# ROCK RIVER WATER RECLAMATION DISTRICT CHERRY VALLEY PUMP STATION UPGRADE CAPITAL PROJECT 1911

### DRAWING INDEX

### PROJECT REFERENCE

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### CHERRY VALLEY PUMP STATION

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30-E-2 ELECTRICAL

### STANDARD DETAILS

99-S-1 STRUCTURAL DETAILS

### REFERENCE DRAWING

INSTRUMENTATION & CONTROL (2011)


### **BOARD OF TRUSTEES**


RICHARD POLLACK JOHN SWEENEY BEN BERNSTEN

PRESIDENT VICE-PRESIDENT CLERK/TREASURER TRUSTEE TRUSTEE

### **OFFICIALS**



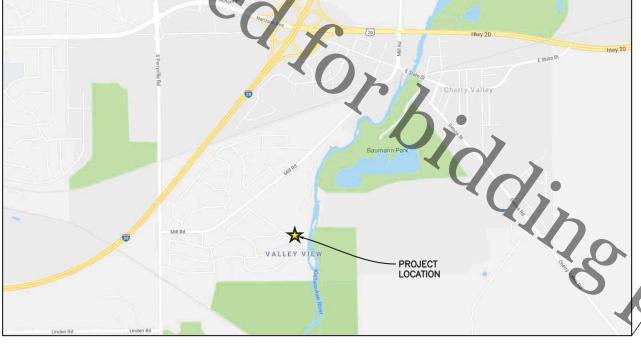

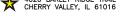

0062-051878



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## **LOCATION MAP**



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ROCKFORD

DRAWING NUMBER DESIGNATION

NDICATES DISCIPLINE

40-SM-2

ARCHITECTURAL

UAL LETTERS INDICATE COMBINED DISCIPLINES

DESIGNED BY: G.A.G.

APPROVED BY: J.J.S. PROJECT NO. 6357

DATE 8-5-19


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10-G-1



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SITE PLAN



### **GENERAL NOTES**

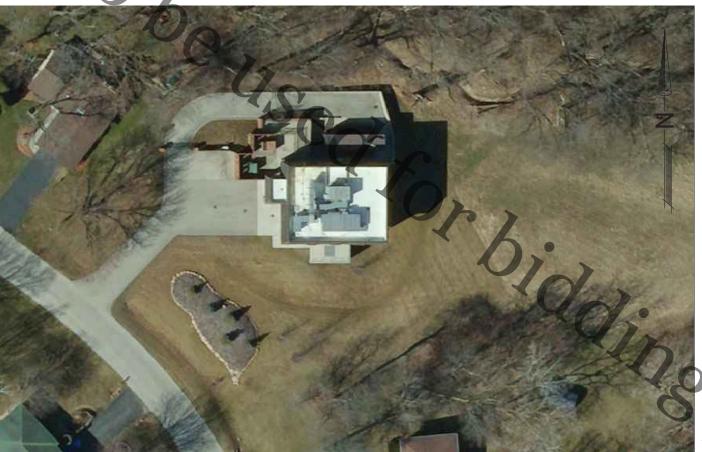THE CONTRACTOR SHALL NOTIFY THE DISTRICT AND ALL LOCAL UTILITY COMPANIES INCLUDING, BUT NOT LIMITED
TO, THE FOLLOWING:

CONTACT: DISTRICT ENGINEERING DEPARTMENT 815-387-7635, 72 HOURS PRIOR TO BEGINNING ANY CONSTRUCTION

> DISTRICT MAINTENANCE SUPERVISOR 815-871-0787, 72 HOURS PRIOR TO BEGINNING ANY CONSTRUCTION.

- 2. THE CHERRY VALLEY PUMP STATION SHALL REMAIN IN CONTINUOUS OPERATIONAL SERVICE AT ALL TIMES DURING CONSTRUCTION, UNLESS OTHERWISE INDICATED IN THE PLANS OR DIRECTED BY THE DISTRICT. ANY PIPING THAT CAN BE REMOVED DURING CONSTRUCTION WITHOUT UNDUE INTERRUPTION OF SERVICE MAY BE REMOVED AND REPLACED BY THE CONTRACTOR WITH PRIOR PERMISSION FROM THE DISTRICT.
- 3. THE CONTRACTOR SHALL BE RESPONSIBLE FOR THE REMOVAL AND LEGAL DISPOSAL OF ALL MATERIALS, EQUIPMENT AND DEBRIS ASSOCIATED WITH THIS PROJECT. THE DISTRICT SHALL HAVE FIRST SALVAGE RIGHTS TO ALL MATERIALS AND EQUIPMENT REMOVED AND THE CONTRACTOR SHALL EXERCISE CARE TO AVOID DAMAGING ITEMS TO BE SALVAGED DURING REMOVAL.
- 4. WHEN CONNECTIONS ARE TO BE MADE TO THE EXISTING PIPING AND STRUCTURES, THE LOCATION AND ELEVATION OF THE EXISTING PIPING SHALL BE FIELD VERIFIED AND NOTIFICATION GIVEN TO THE DISTRICT PRIOR TO WORK BEING PERFORMED. IF THE EXISTING PIPING IS FOUND TO BE SUBSTANTIALLY DIFFERENT THAN THAT SHOWN ON THE DRAWINGS, THE DISTRICT WILL PROVIDE WRITTEN DIRECTION FOR THE CORRECTIVE ACTION TO BE TAKEN.
- COORDINATE WITH THE DISTRICT TO IDENTIFY EQUIPMENT/MATERIALS TO BE REMOVED AND DELIVERED TO THE
  DISTRICT WASTEWATER TREATMENT PLANT AT 3333 KISHWAUKEE ST., ROCKFORD, IL.. ALL COMPONENTS AND
  EQUIPMENT SLATED BY THE DISTRICT FOR SALVAGE SHALL BE TAGGED.

### **CONSTRUCTION SEQUENCING**

- THE CHERRY VALLEY PUMP STATION SHALL REMAIN IN OPERATION FOR THE DURATION OF CONSTRUCTION.
  REPLACEMENT OF THE PUMPS NO. 2 AND NO. 3 SHALL OCCUR SEQUENTIALLY SUCH THAT A MAXIMUM OF ONE (1)
  PUMP WILL BE OUT OF SERVICE AT ANY GIVEN TIME. EQUIPMENT SHUTDOWNS SHALL BE SCHEDULED 72 HOURS IN
  ADVANCE WITH THE DISTRICT PLANT MAINTENANCE SUPERVISOR.
- 2. CONTRACTOR SHALL HAVE ALL MATERIALS NEEDED FOR THE NEW PUMP EQUIPMENT INSTALLATION ON HAND PRIOR TO THE START OF DEMOLITION OF THE EXISTING PUMP EQUIPMENT.
- DISCONNECT POWER TO PUMP NO. 2 AND REMOVE THE ASSOCIATED VARIABLE FREQUENCY DRIVE (VFD) PER ELECTRICAL PLANS AND SPECIFICATIONS.
- 4. REMOVE EXISTING PUMP MOTOR, PUMP BASE, PIPING AND APPURTENANCES AS SHOWN ON SHEET 30-MR- 1.
- 5. INSTALL NEW PUMP NO. 2, PIPING, VFD AND APPURTENANCES.
- 6. INSTALL NEW MOTOR SUPPORT PER SHEET 99-S-1. INSTALL NEW MOTOR.
- 7. PROVIDE NEW CONDUIT AND WIRING TO PUMP NO. 2. SEE ELECTRICAL PLANS AND SPECIFICATIONS FOR DETAIL.
- 8. COORDINATE RUMP TESTING AND STARTUP FOR PUMP NO. 2 PER MANUFACTURERS RECOMMENDATIONS AS IDENTIFIED IN APPENDIX A AND APPENDIX B.
- 9. WHEN PUMP NO. 2 INSTALLATION AND STARTUP IS COMPLETE, REPEAT SEQUENCE FOR PUMP NO. 3.



ROCK RIVER WATER
RECLAMATION DISTRICT
3501 KISHWAUKEE STREET
ROCKFORD, ILLINOIS 61109
(815) 387-7660

No. DATE REVISION

8/02/19

BD


CHERRY VALLEY PUMP STATION PUMP REPLACEMENT
CAPITAL IMPROVEMENT PROJECT #1911


SITE PLAN

Sheet No. 10-G-2

Date 8/6/2019

t Projects/Cherry Valley Lift Station Pump Replacement 1911/Engineering/Dwgs/Pump Replac

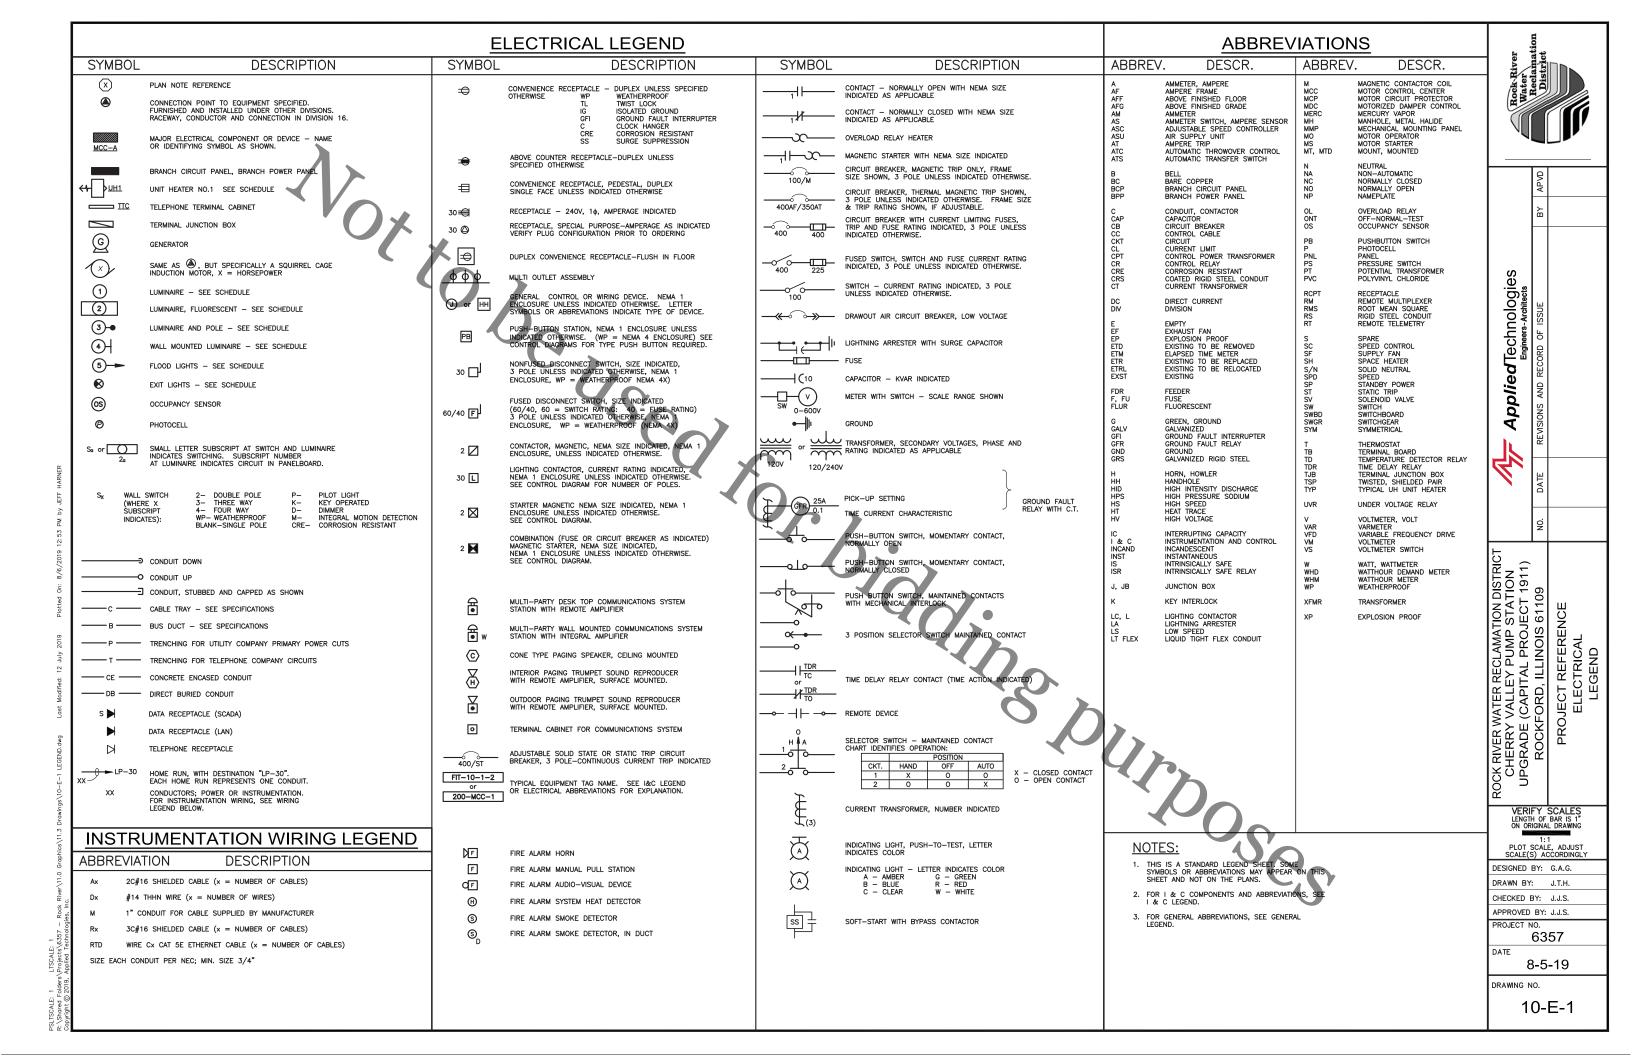

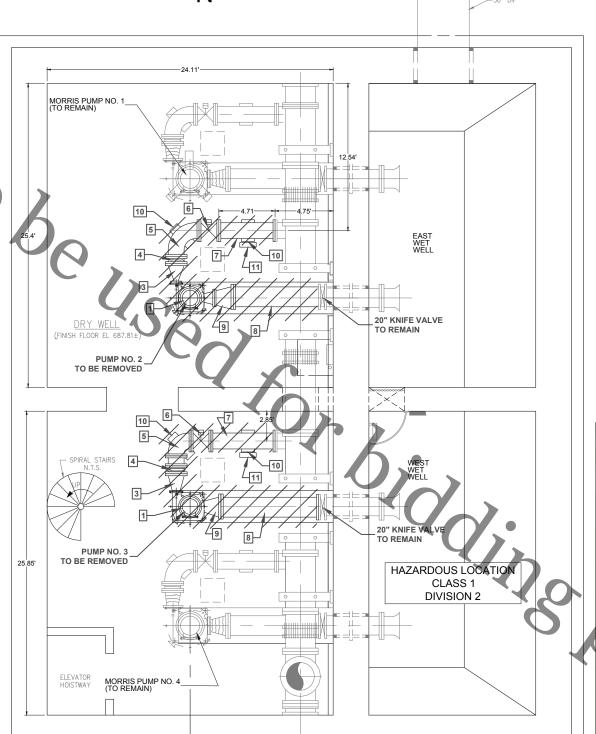





PUMP NO. 2 AND PIPING





PUMP NO. 3 AND PIPING

### LOWER LEVEL DEMOLITION PLAN

SCALE: 1"=4'



ROCK RIVER WATER
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3501 KISHWAUKEE STREET
ROCKFORD, ILLINOIS 61109
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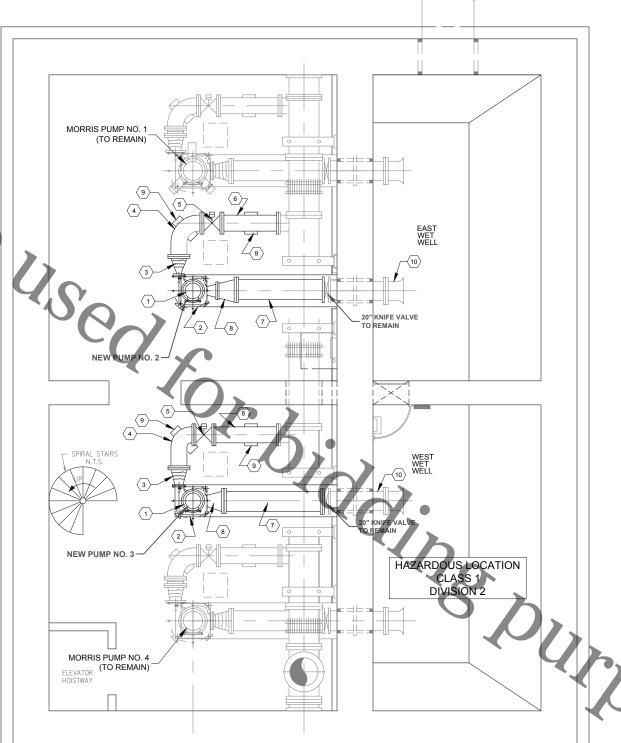
CHERRY VALLEY PUMP STATION PUMP REPLACEMENT
CAPITAL IMPROVEMENT PROJECT #1911

MECHANICAL/REMOVAL PLAN

Sheet No. 30-MR- 1

Date 8/6/2019





#### **GENERAL NOTES**

- EXISTING PROCESS PIPING IN THE LOWER LEVEL IS BELIEVED TO BE DUCTILE IRON. CONTRACTOR SHALL BE RESPONSIBLE FOR VERIFYING.
- 2 ALL NEW PROCESS PIPING FROM THE EXISTING PIPING TO THE PROPOSED PUMPS (INCLUDING PIPES, FITTINGS, ETC.) SHALL BE PAINTED ANSI 70 GRAY.

### **KEY NOTES**

- NEW MORRIS 7100NC PUMP, TYPICAL OF 2, PUMP ASSEMBLY INCLUDING PUMP, MOTOR, SUCTION BASE, ELBOW, SOLE PLATE, AND SHAFTING WILL BE FURNISHED BY RRWRD. SEE APPENDIX A OF THE SPECIFICATIONS FOR APPROVED PUMP SUBMITTAL. NEW PUMP NO. 2 SHALL BE THE FIRST PUMP INSTALLED.
- NEW PUMP BASES (SEE STRUCTURAL SHEET 99-S-1)
- NEW 16"x12" FLEXIBLE ECCENTRIC REDUCER
- NEW 16" PIPE ELBOW
- NEW 16" OPERATED CYLINDER ECCENTRIC PLUG VALVE
- NEW 16" DUCTILE IRON PIPE
- NEW 20" DUCTILE IRON PIPE NEW 20"x14" ECCENTRIC REDUCER
- NEW CONCRETE PIPE SUPPORTS (SEE STRUCTURAL SHEET 99-S-1)
- REMOVE DEBRIS FROM EXISTING 20" KNIFE VALVE TO END OF SUCTION LINE IN WET WELL. COORDINATE WITH OWNER, ACCESS TO THE WET WELL TO CLEAN THE 20" SUCTION LINE BY JETTING THE LINE. THE DEBRIS MAY BE LEFT IN THE WET WELL. EXCESS DEBRIS NEAR SUCTION LINE SHALL BE DISPERSED TO PREVENT INFLUX OF CONCENTRATED SOLIDS INTO PUMP DURING START-UP.

LOWER LEVEL REPLACEMENT PLAN

**ROCK RIVER WATER RECLAMATION DISTRICT** 3501 KISHWAUKEE STREET **ROCKFORD, ILLINOIS 61109** (815) 387-7660


No. DATE REVISION 8/02/19

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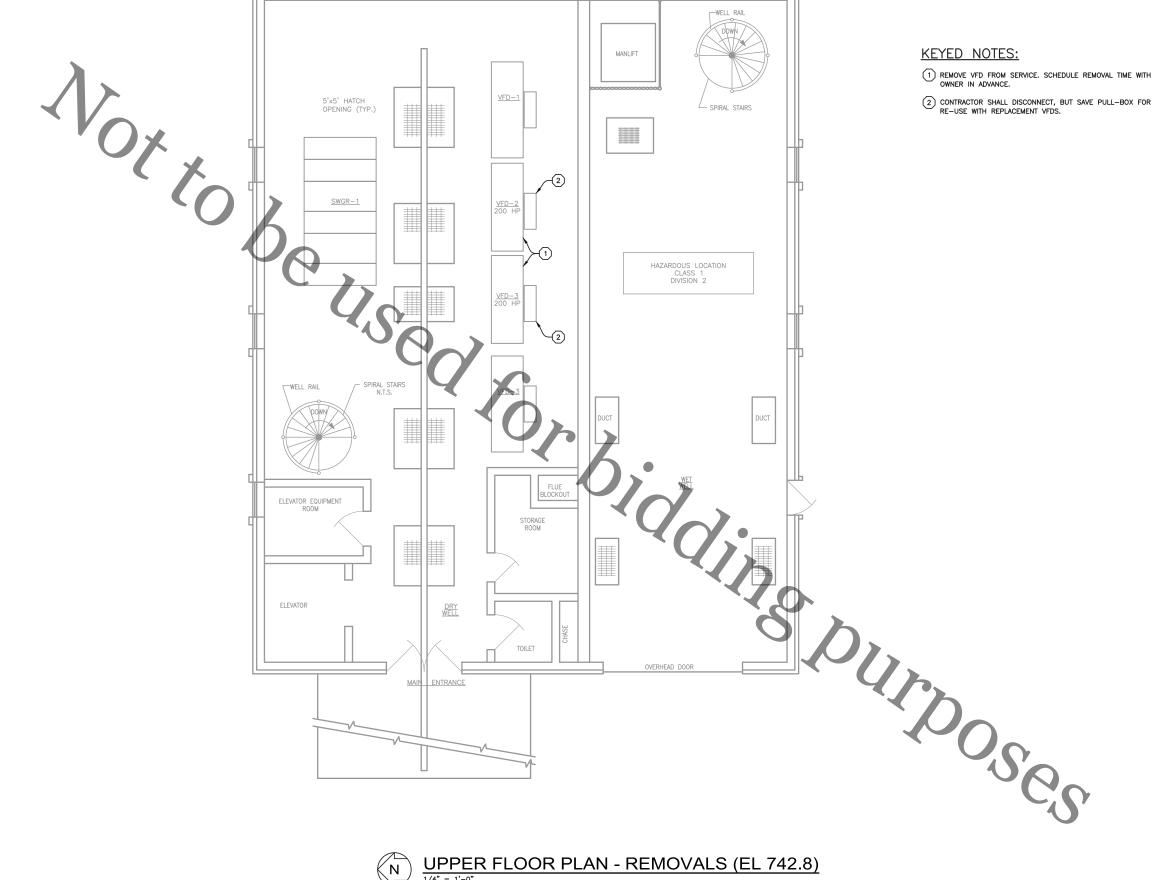
**CHERRY VALLEY PUMP STATION PUMP REPLACEMENT CAPITAL IMPROVEMENT PROJECT #1911** 

**MECHANICAL REPLACEMENT PLAN**  Sheet No. 30-M- 1

Date 8/6/2019

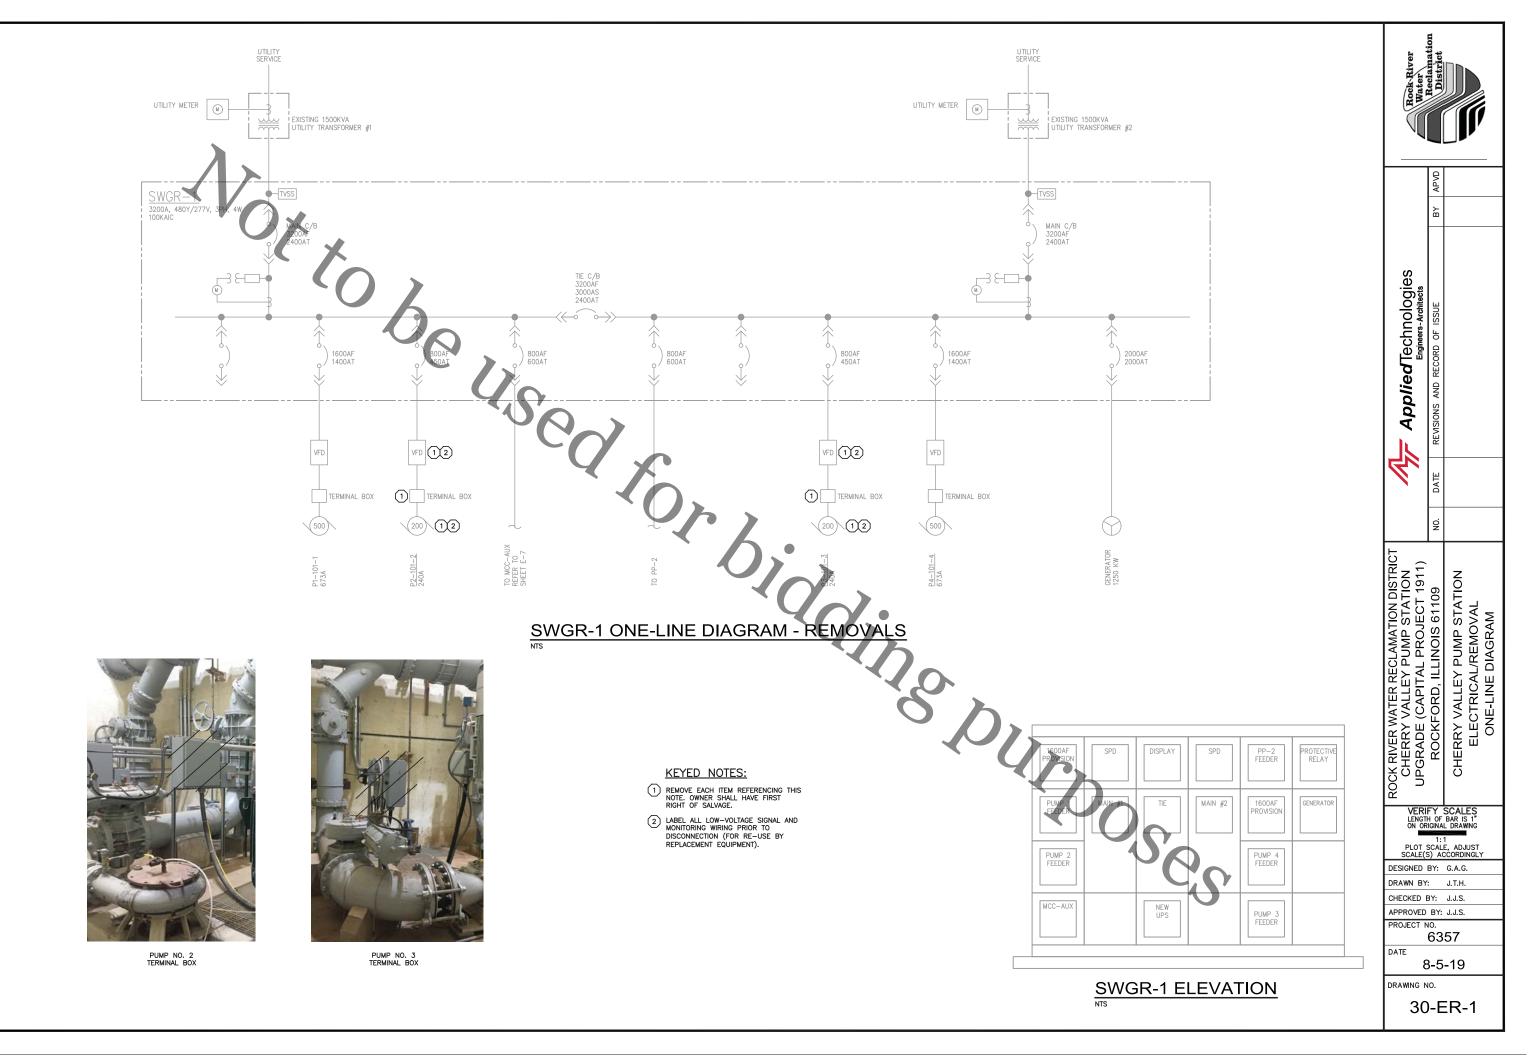

PSLTSCALE: 1 LTSCALE: 1 R:\Shared Folders\Projects\6357 - Rock River\11.0 Graphics\11.3 Drawings\3



UPPER FLOOR PLAN - REMOVALS (EL 742.8)

N PLAN NORTH

VERIFY SCALES LENGTH OF BAR IS 1" ON ORIGINAL DRAWNO

DESIGNED BY: G.A.G. DRAWN BY:

ROCK RIVER WATER RECLAMATION DISTRICT CHERRY VALLEY PUMP STATION UPGRADE (CAPITAL PROJECT 1911) ROCKFORD, ILLINOIS 61109

CHERRY VALLEY PUMP STATION ELECTRICAL/REMOVAL PLAN

CHECKED BY: J.J.S.

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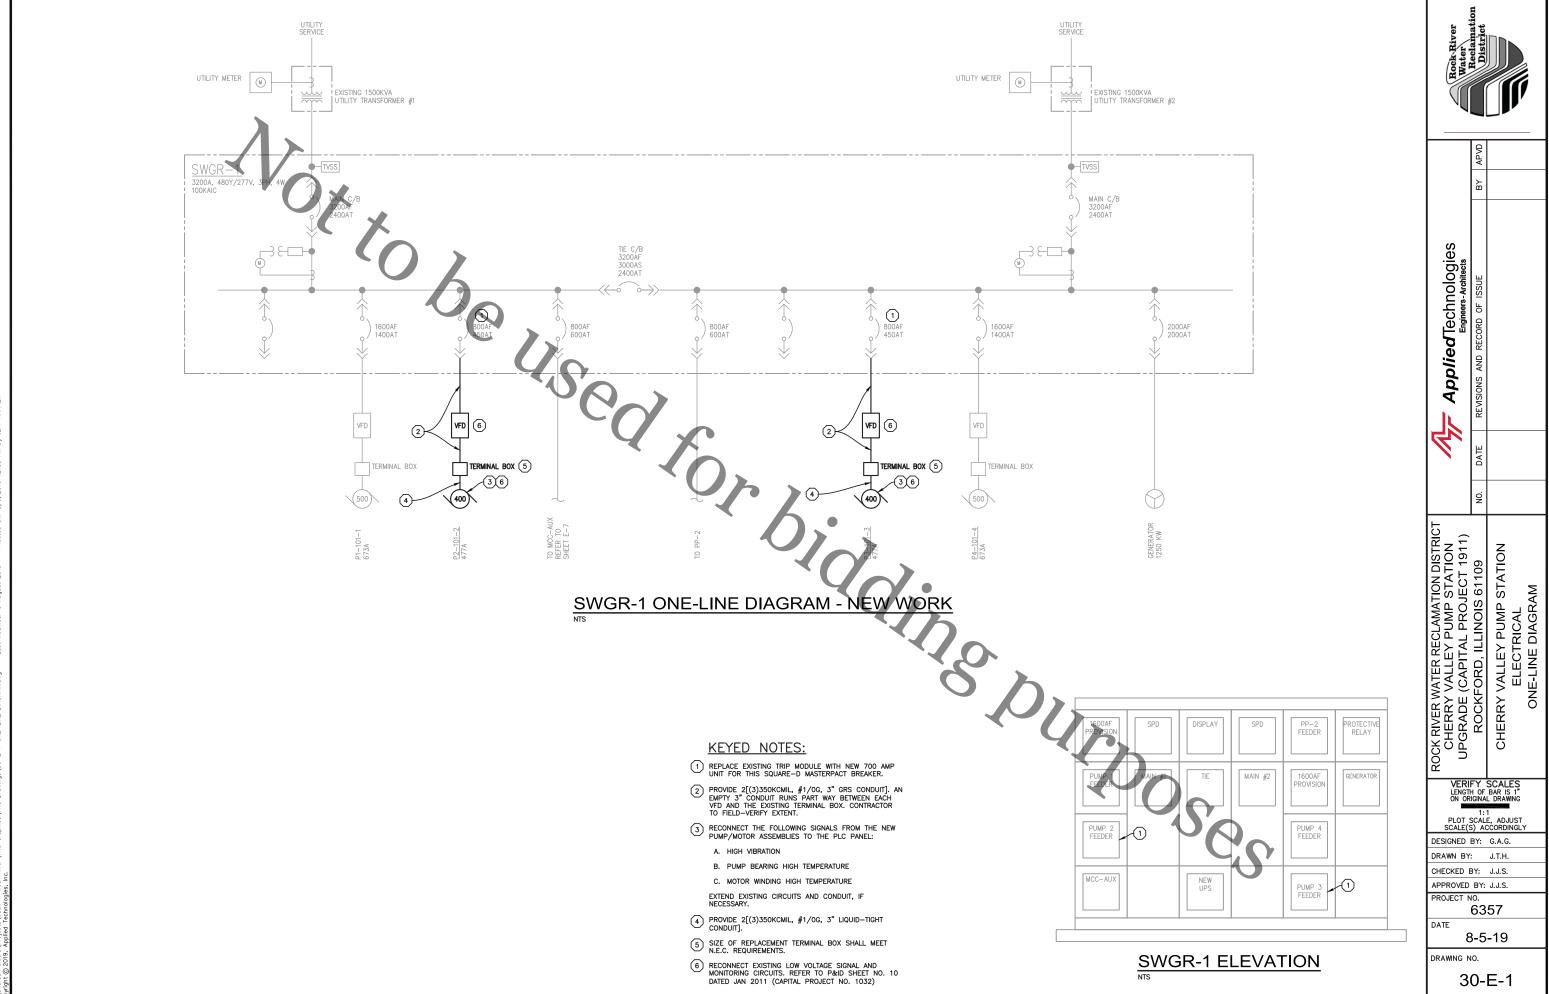
APPROVED BY: J.J.S.

PROJECT NO. 6357

DATE 8-5-19

DRAWING NO.

30-ER-2









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ROCK RIVER WATER RECLAMATION DISTRICT CHERRY VALLEY PUMP STATION UPGRADE (CAPITAL PROJECT 1911) ROCKFORD, ILLINOIS 61109 CHERRY VALLEY PUMP STATION ELECTRICAL PLAN

VERIFY SCALES LENGTH OF BAR IS 1" ON ORIGINAL DRAWNO

DESIGNED BY: G.A.G. DRAWN BY:


CHECKED BY: J.J.S. APPROVED BY: J.J.S.

PROJECT NO. 6357

DATE 8-5-19

DRAWING NO.

30-E-2

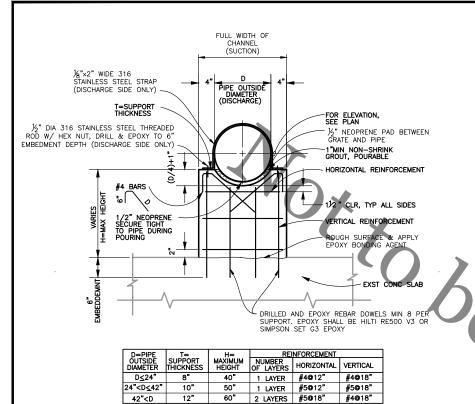


REFER ALSO TO SECTIONS 03100, 03200, AND 03300 FOR ADDITIONAL REQUIREMENTS.

PROPOSED CONCRETE PIPE SUPPORT


42"<D

03760

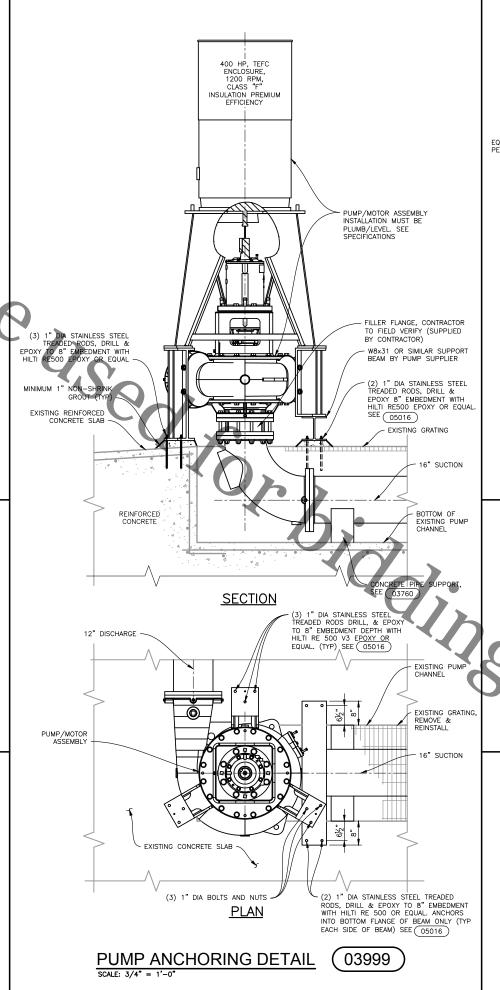

### **GENERAL NOTES:**

- 1. CONTRACTOR TO CONFIRM ELEVATIONS.
- 2. NON-SHRINK OR HIGH PRECISION GROUT UNDER ALL EQUIPMENT SUPPORTS.
- 3. PROVIDE SUPPORT UNDER BOTH SUCTION AND DISCHARGE PIPES.
- 4. PROVIDE WEDGES OR SHIMS UNDER EQUIPMENT WHILE GROUT IS PLACED.

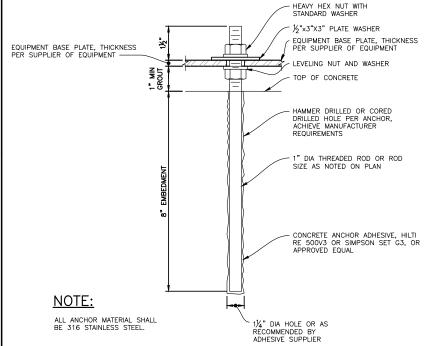

05016 ANCHOR BOLT DETAIL

-100scs

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ROCK RIVER WATER RECLAMATION DISTRICT CHERRY VALLEY PUMP STATION UPGRADE (CAPITAL PROJECT 1911) ROCKFORD, ILLINOIS 61109 STANDARD DETAILS STRUCTURAL DETAILS

VERIFY SCALES LENGTH OF BAR IS 1" ON ORIGINAL DRAWN( PLOT SCALE, ADJUST SCALE(S) ACCORDINGLY

DESIGNED BY: B.A.G.

DRAWN BY: J.C.S. CHECKED BY: J.J.S.

APPROVED BY: J.J.S. PROJECT NO.

6357 DATE

DRAWING NO.

99-S-1

8-5-19

